


SITE PLAN
SCALE :- 1:200

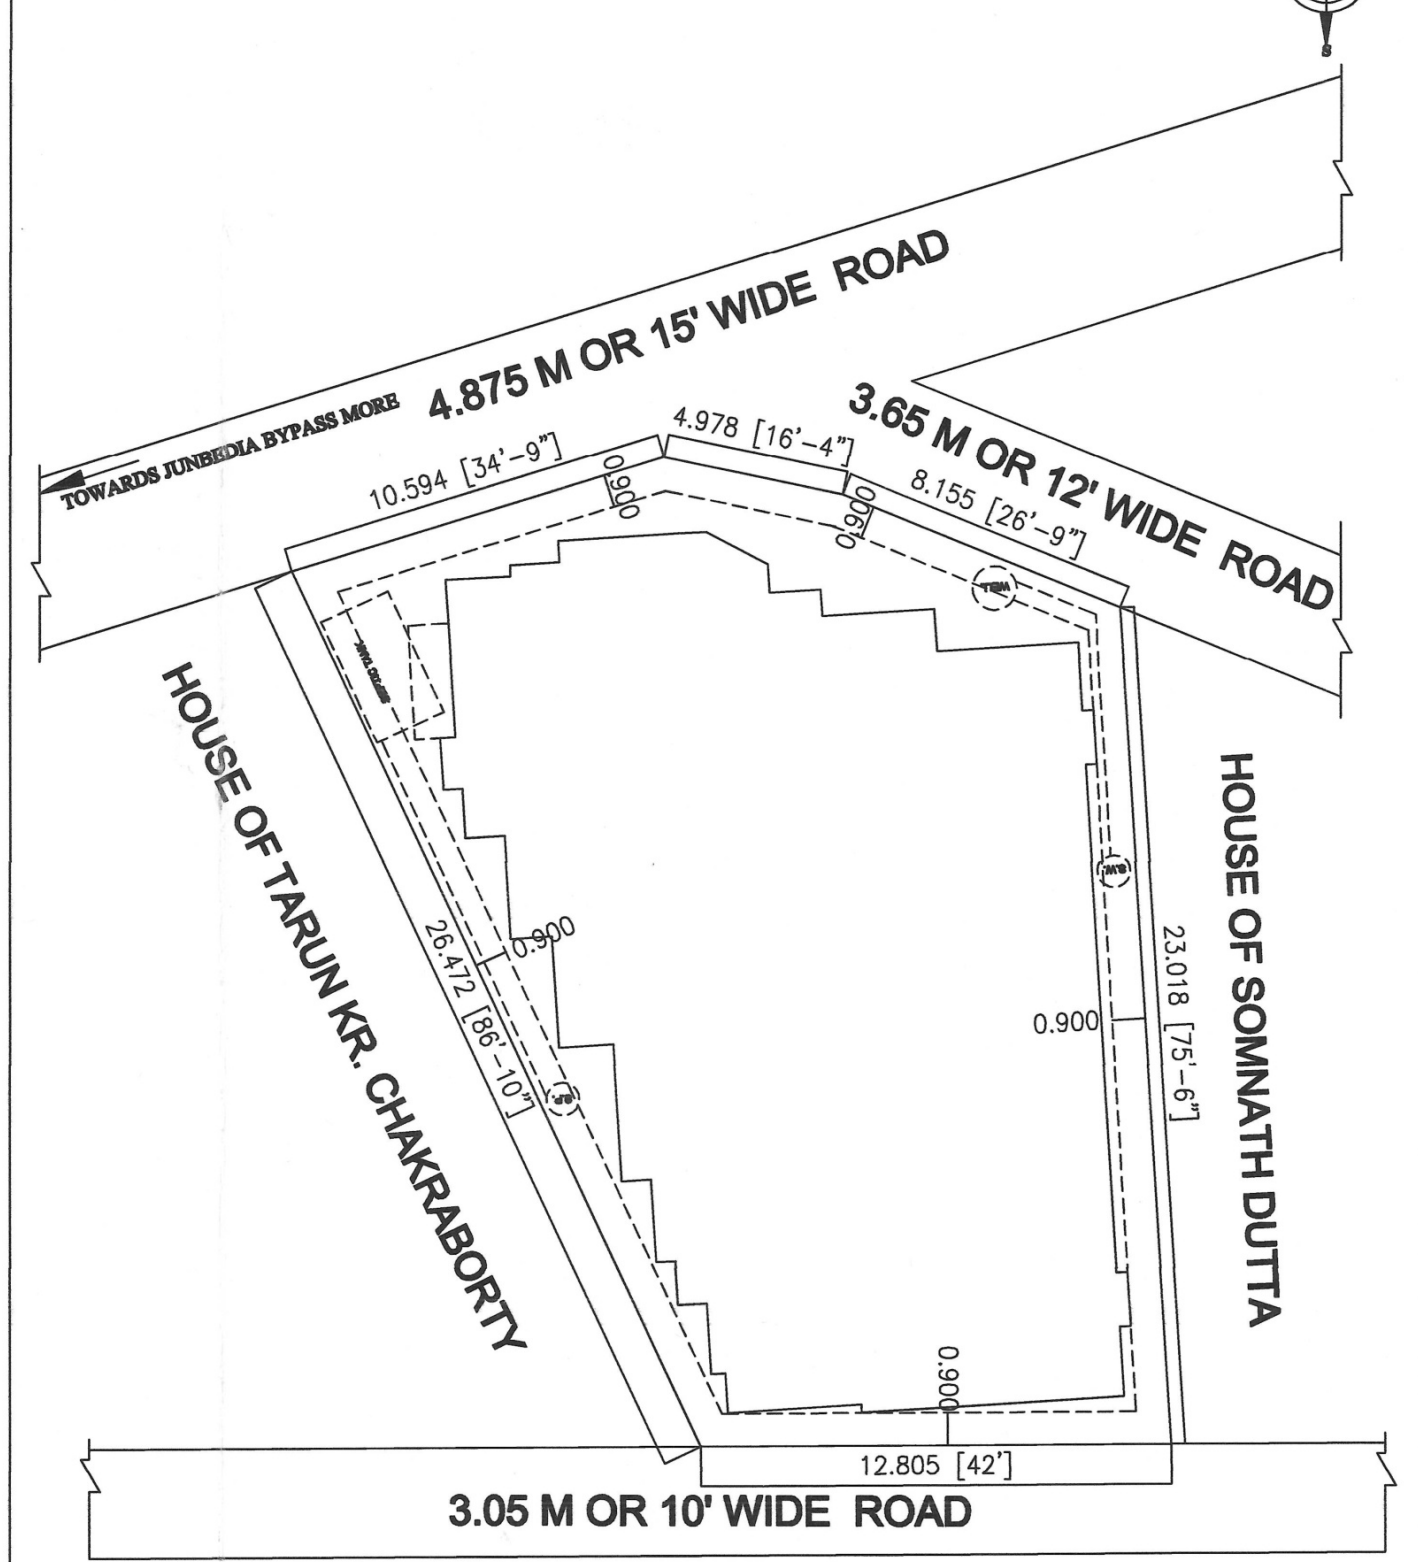

ARCHITECTURAL DRAWING OF PROPOSED G+4 RESIDENTIAL APARTMENT BUILDING ON PLOT NO:-736 / 1009 (L.R.), J.L.NO:-229, K.H.NO:-3948, 3950, 3949, 3951, 3952, MOUZA:- JUNBEDIA. UNDER JUNBEDIA GRAM PANCHAYAT, P.S.+ DIST:- BANKURA.

NAME OF OWNER :- 1. SAYANDIP RAKSHIT, 2. KALPANA RAKSHIT, 3. PRIYA RAKSHIT, 4. SHWETA SUHASARIA, 5. BIPAN MUKHERJEE

AREA STATEMENT
 AREA OF PLOT (AS PER DEED)- 462.336 SQM OR 4974 SQFT
 AREA OF PLOT (AS PER MUTATION)- 0.12 ACRE
 PROPOSED GROUND FLOOR AREA = 308.224 SQ.M OR 3316.00 SQFT.
 PROPOSED RESIDENTIAL FIRST FLOOR AREA = 332.30 SQ.M OR 3575.02 SQFT.
 PROPOSED RESIDENTIAL SECOND FLOOR AREA = 332.30 SQ.M OR 3575.02 SQFT.
 PROPOSED RESIDENTIAL THIRD FLOOR AREA = 332.30 SQ.M OR 3575.02 SQFT.
 PROPOSED RESIDENTIAL FOURTH FLOOR AREA = 332.30 SQ.M OR 3575.02 SQFT.

1. Sayandip Rakshit 2. Kalpana Rakshit
 3. Priya Rakshit 4. Shweta Suhasaria
 5. Bipan Mukherjee

SIGNATURE OF OWNER

Dayamay Barah
 DAYAMAY BARAH
 B. Tech. In CE
 Bankura Municipality
 Licence No.-LBS-Class-I (6)/2021-24
 Mobile :- 8116823552

SIGN. OF L.B.S.

Dayamay Barah
 DAYAMAY BARAH
 Enlisted Structural Engineer
 Bankura Municipality
 License No. (S)-1/2021-24
 Mobile :- 8116823552

SIGN. OF STRUCTURAL ENGINEER

COLOUR INDEX

| | |
|--------------------------|-------|
| EXISTING BUILDING | _____ |
| PROPERTY LINE | _____ |
| PROPOSED BUILDING LINE | _____ |
| DRAINAGE & SEWERAGE LINE | _____ |
| ROAD LINE | _____ |

DOOR & WINDOW SCHEDULE

| TYPE | SIZE (DOOR) | TYPE | SIZE (DOOR) |
|------|-------------|------|-------------|
| D | 2100X2100 | W | 2400X1200 |
| D1 | 1800X2100 | W1 | 1500X1200 |
| D2 | 1200X2100 | W2 | 1200X1200 |
| D3 | 1050X2100 | W3 | 900X1200 |
| D4 | 900X2100 | W4 | 700X600 |
| D5 | 750X2100 | W5 | 1800X1200 |
| | | W6 | 750X1200 |
| | | W7 | 600X600 |

SANCTIONED BY

Approve
Sujata Das
 Assistant Engineer
 (P. & R.D.)
 Bankura Zilla Parishad


NOTE

1. ALL DIMENSION ARE IN MM.
2. ALL OUTER WALL - 200 MM TH
3. ALL INNER WALL - 125 & 75 MM MM
4. GRADE OF CONCRETE - M-20 AND STEEL - Fe 415
5. SCALE :- 1 : 100


ARCH. SHEET NO - 1 OF 2




FRONT ELEVATION
SCALE- 1:100

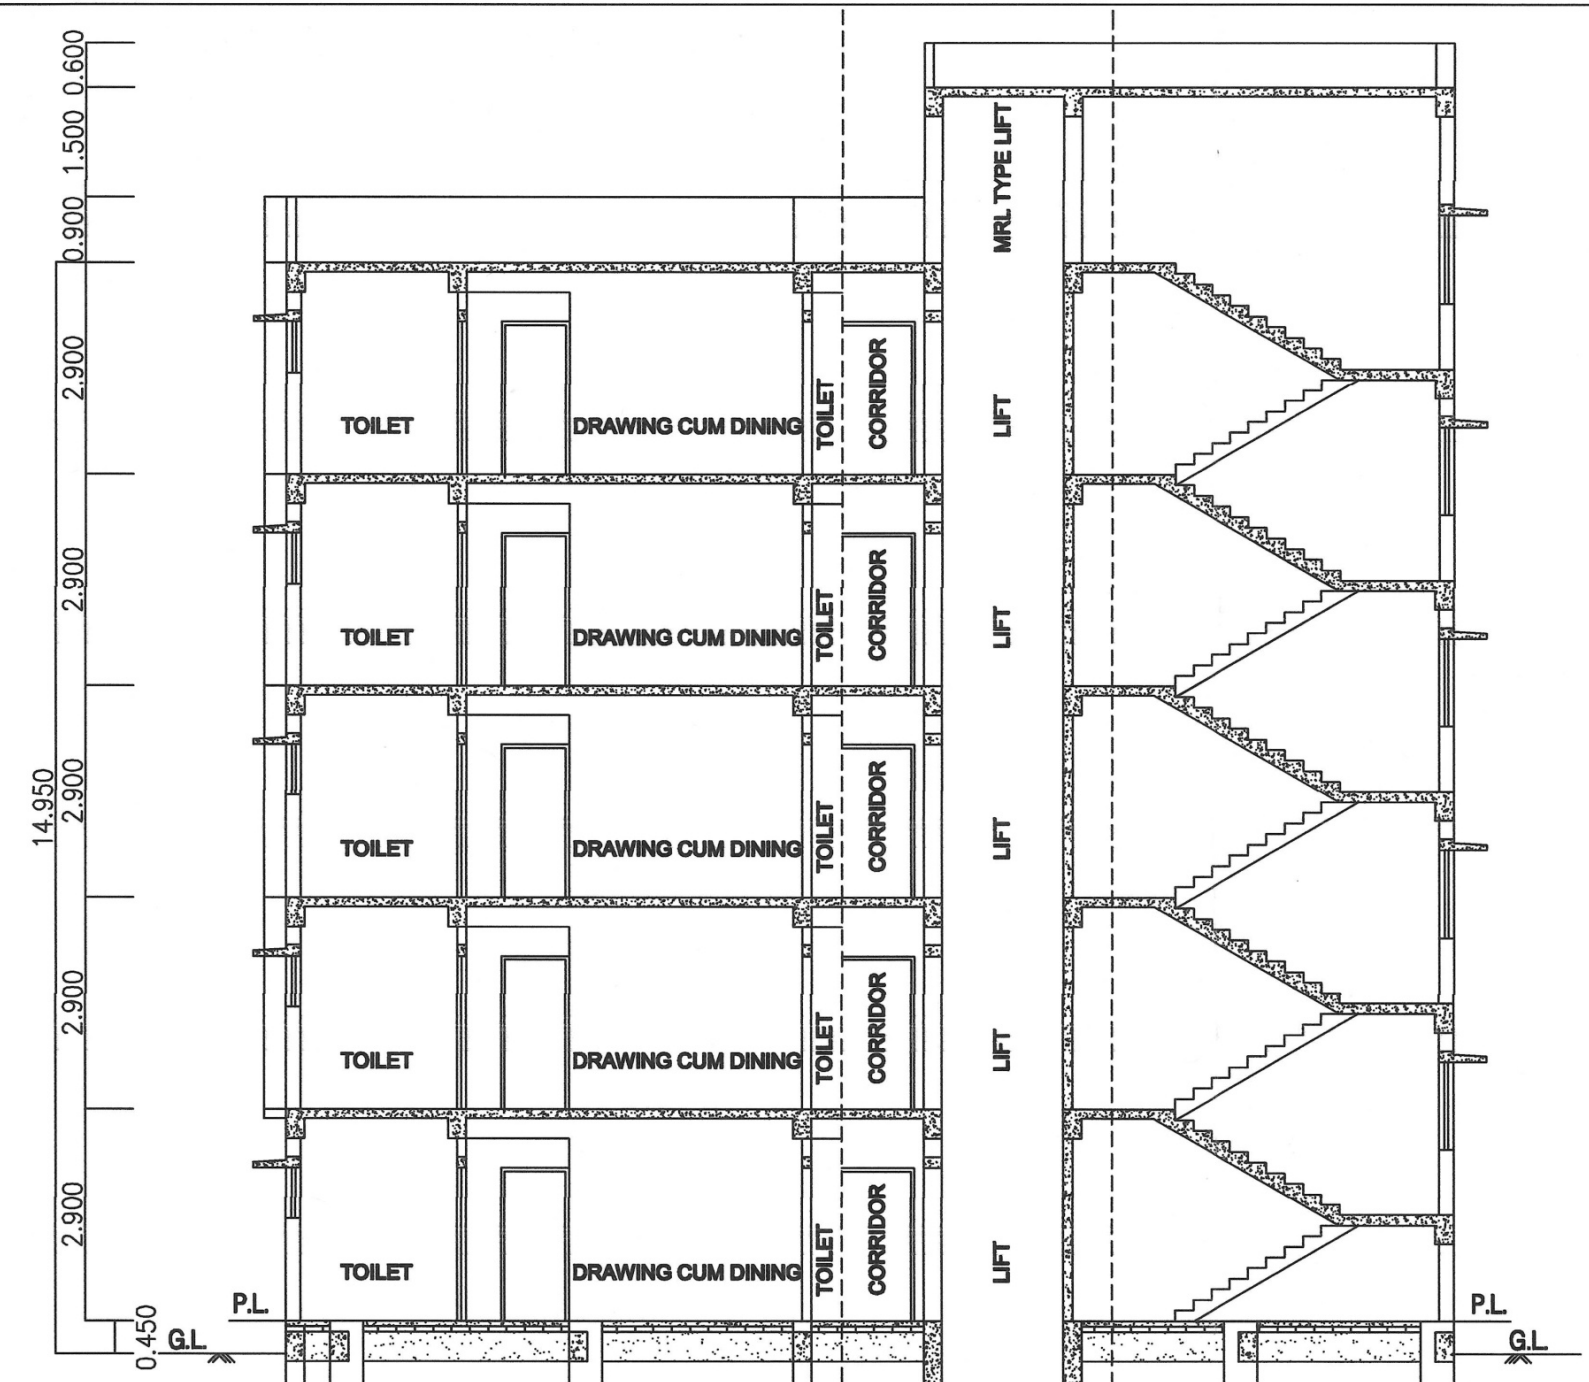


SECTION ON A-B
SCALE- 1:100

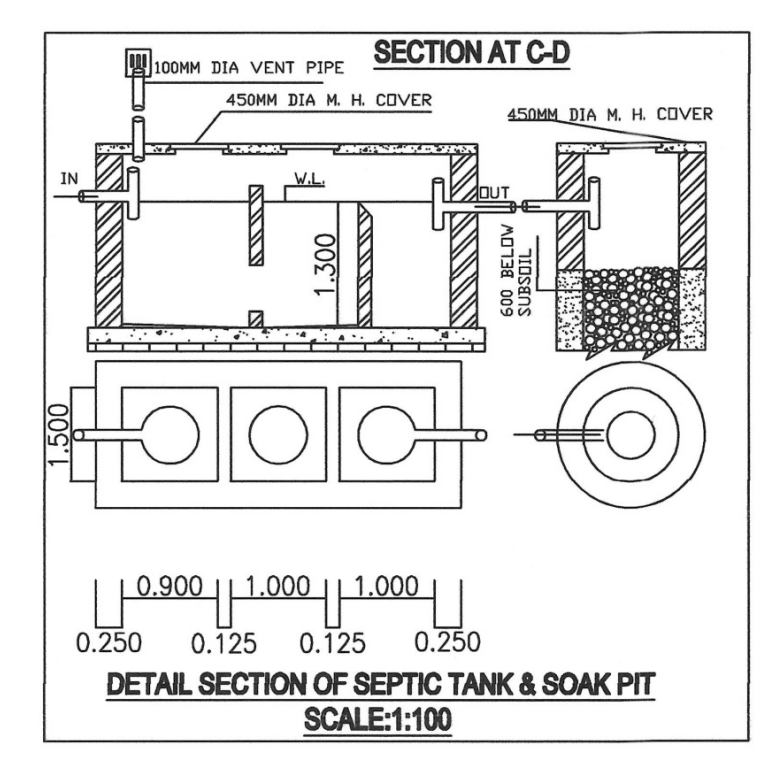


DETAIL SECTION OF SEPTIC TANK & SOAK PIT
SCALE:1:100

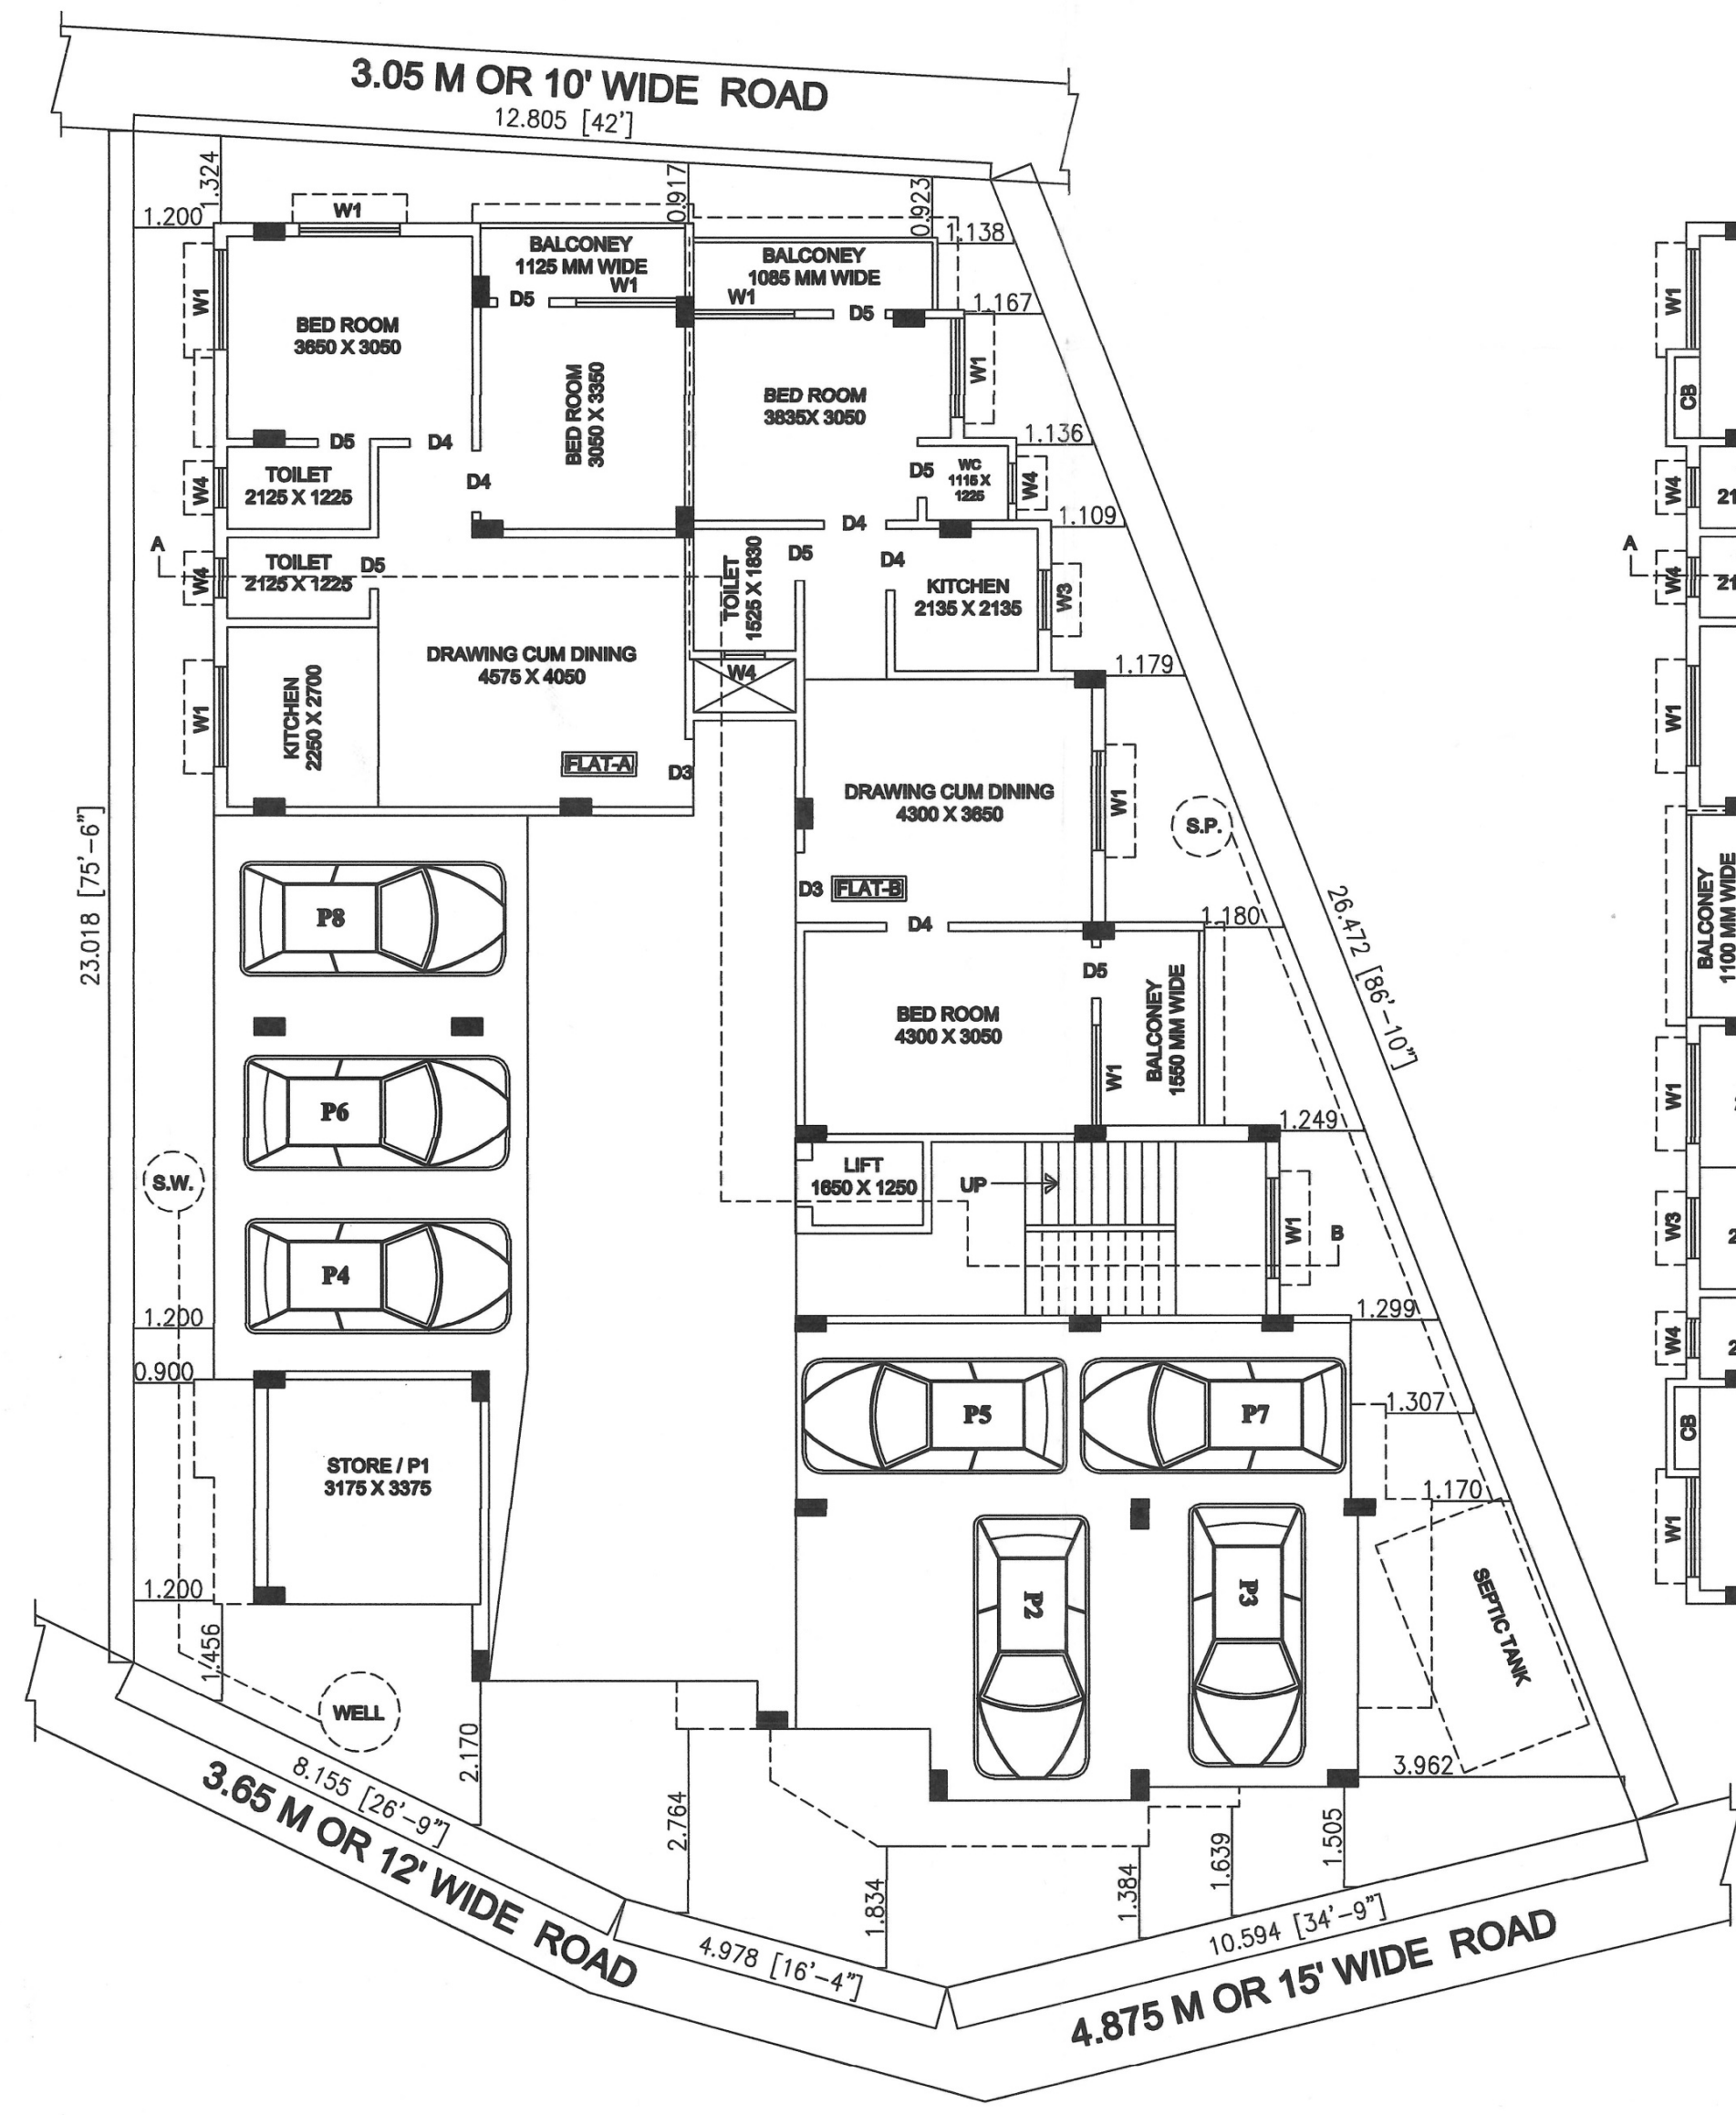

PROPOSED GROUND FLOOR PLAN
SCALE-1:100

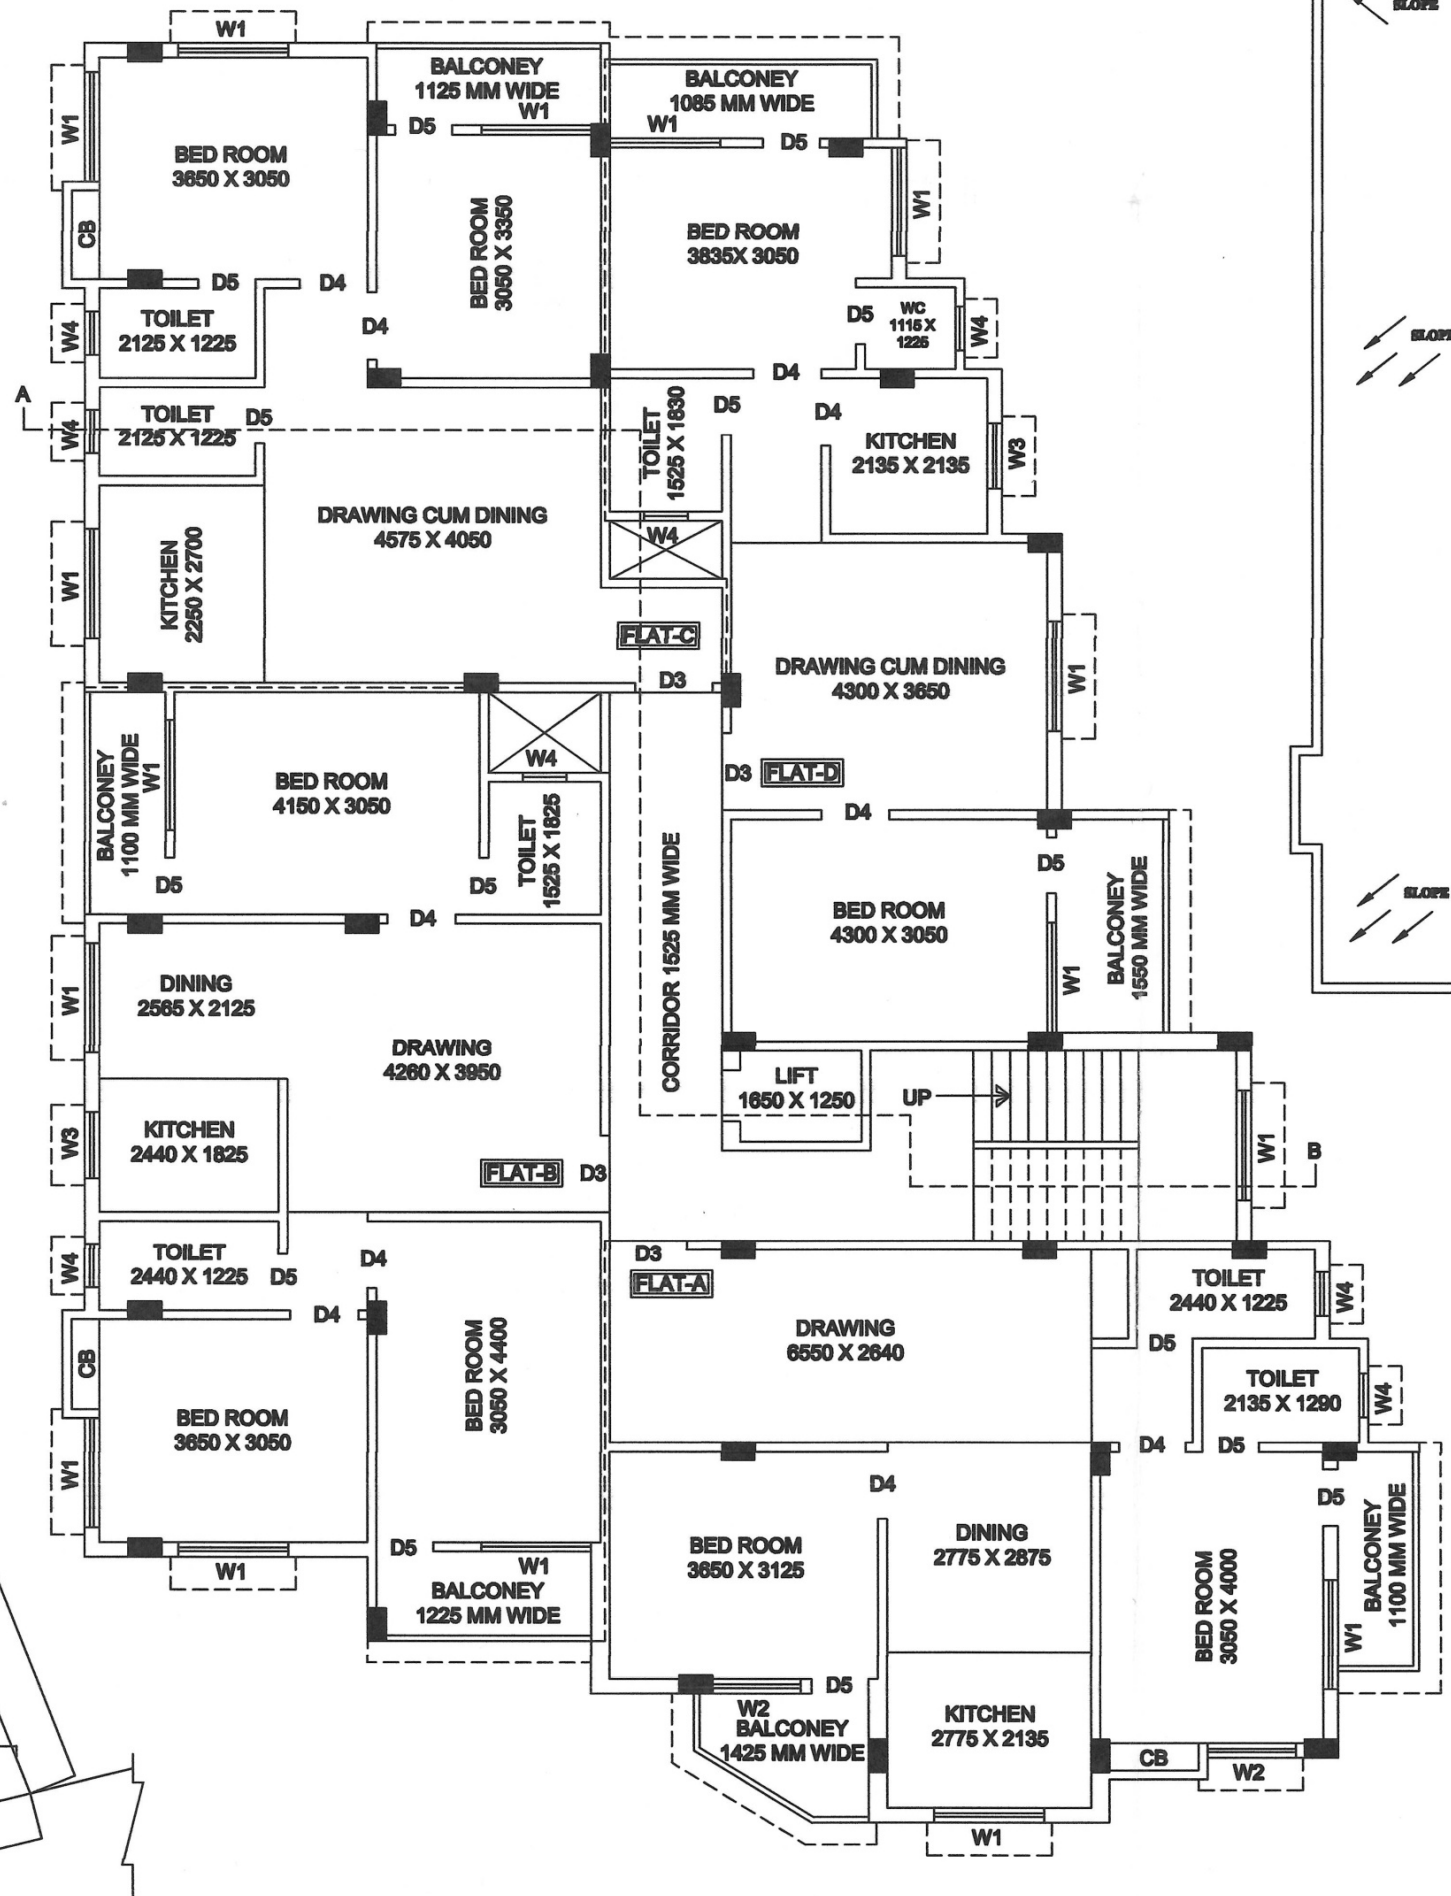

PROPOSED FIRST, SECOND, THIRD & FOURTH FLOOR TYPICAL PLAN
SCALE- 1:100

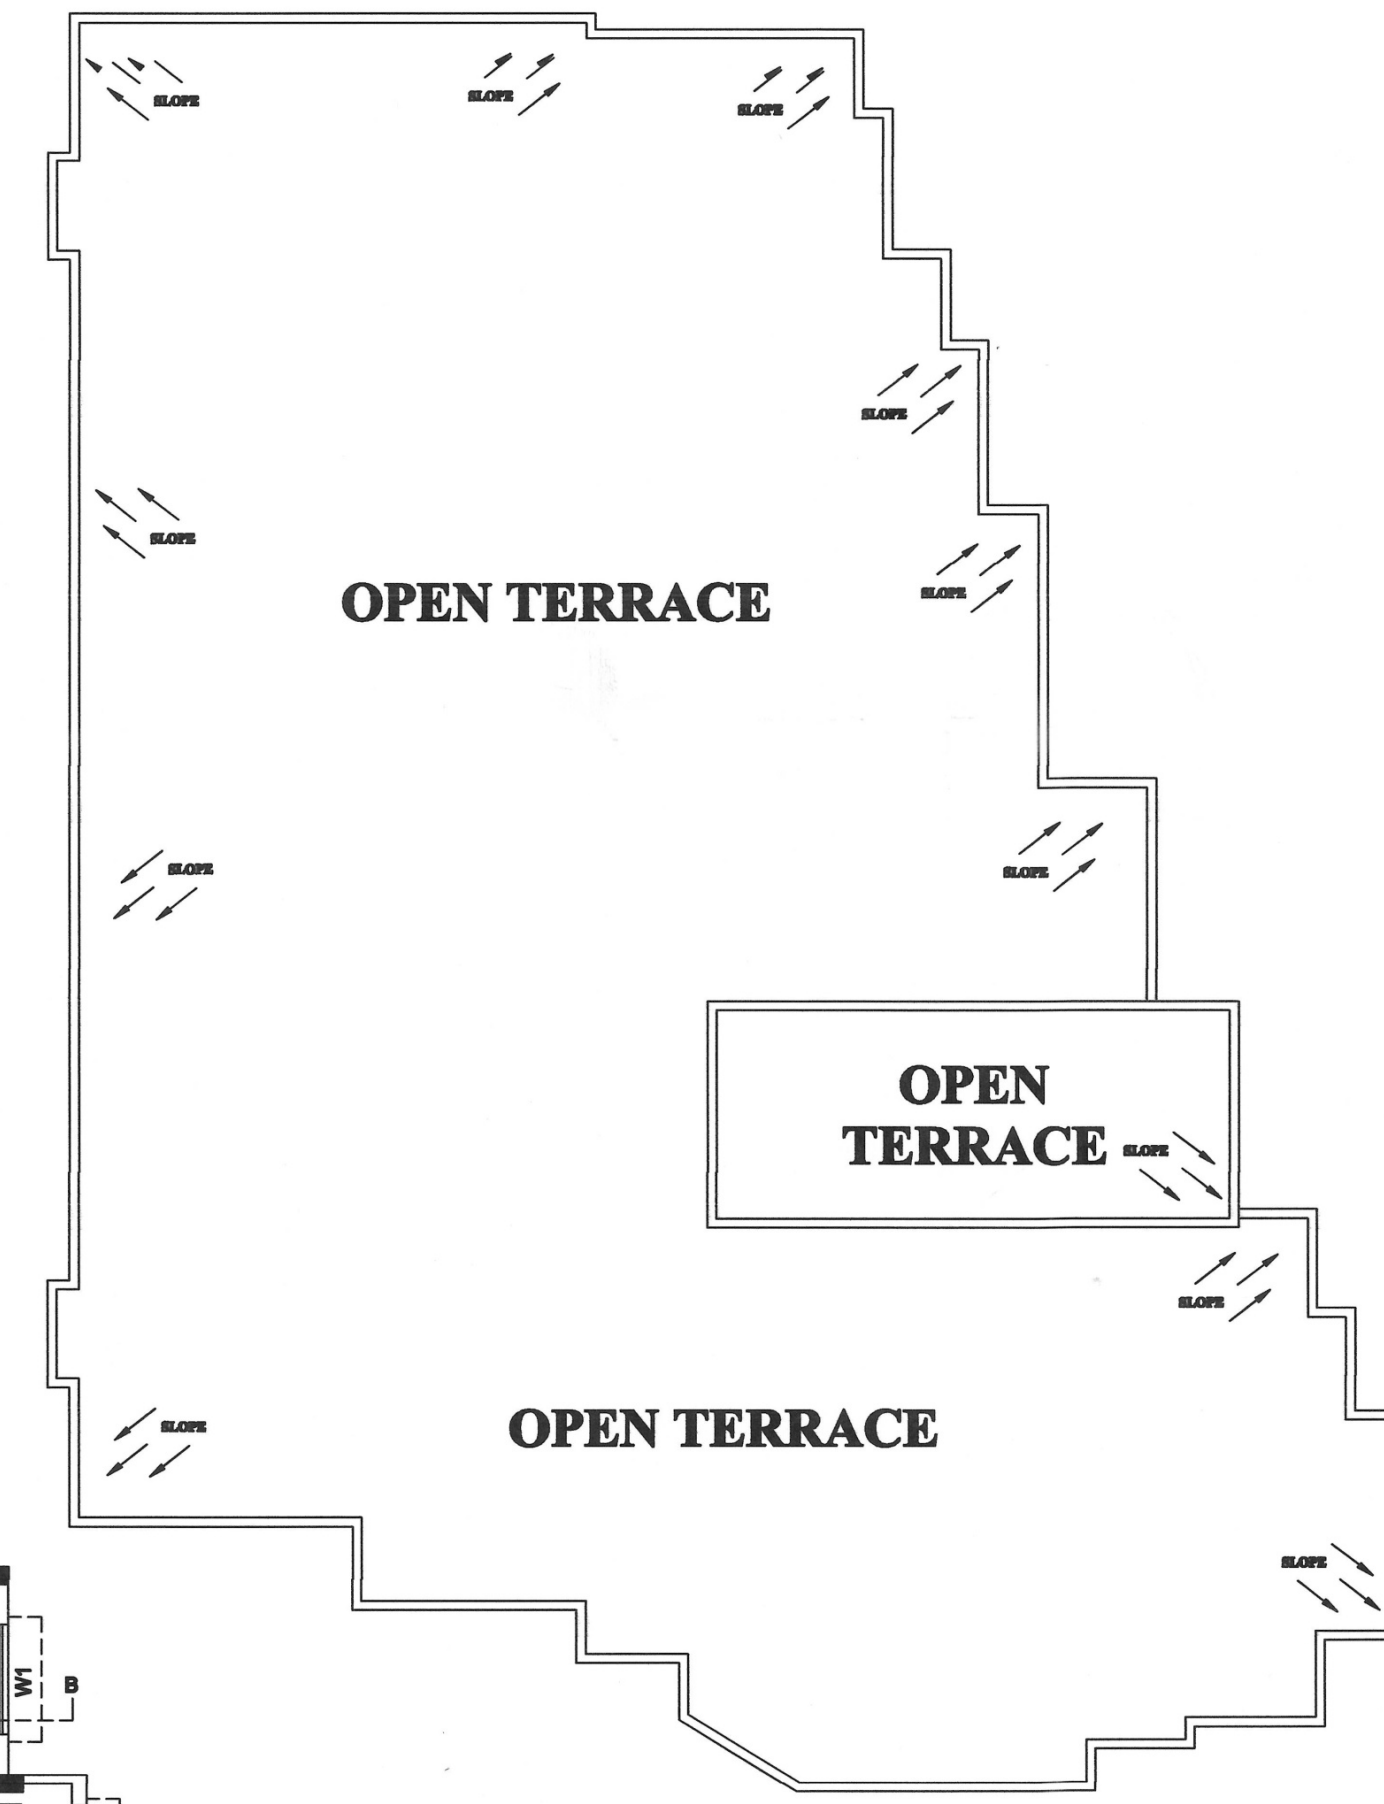

ROOF PLAN
SCALE- 1:100